




PLAN VIEW — PROPOSED DRAINAGE LAYOUT
SCALE 1:500 @A1

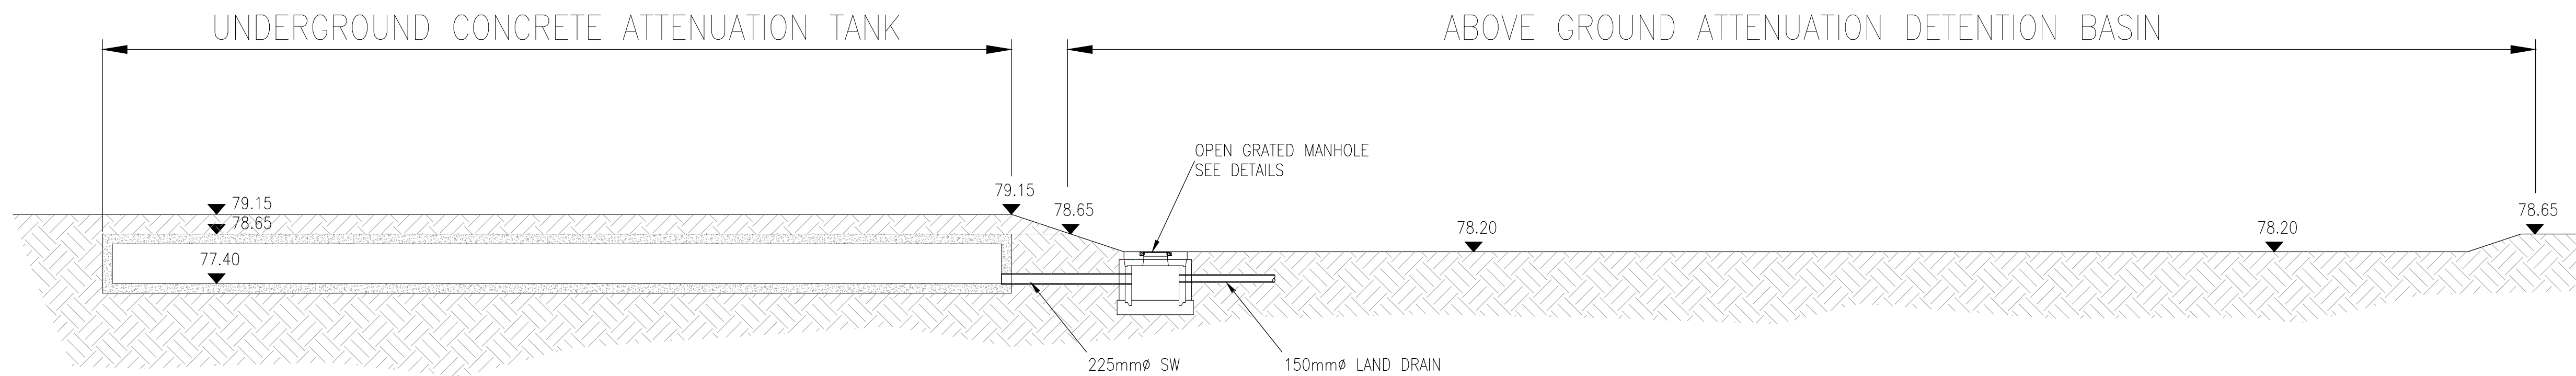


SECTION A-A
SCALE 1:100 @A1

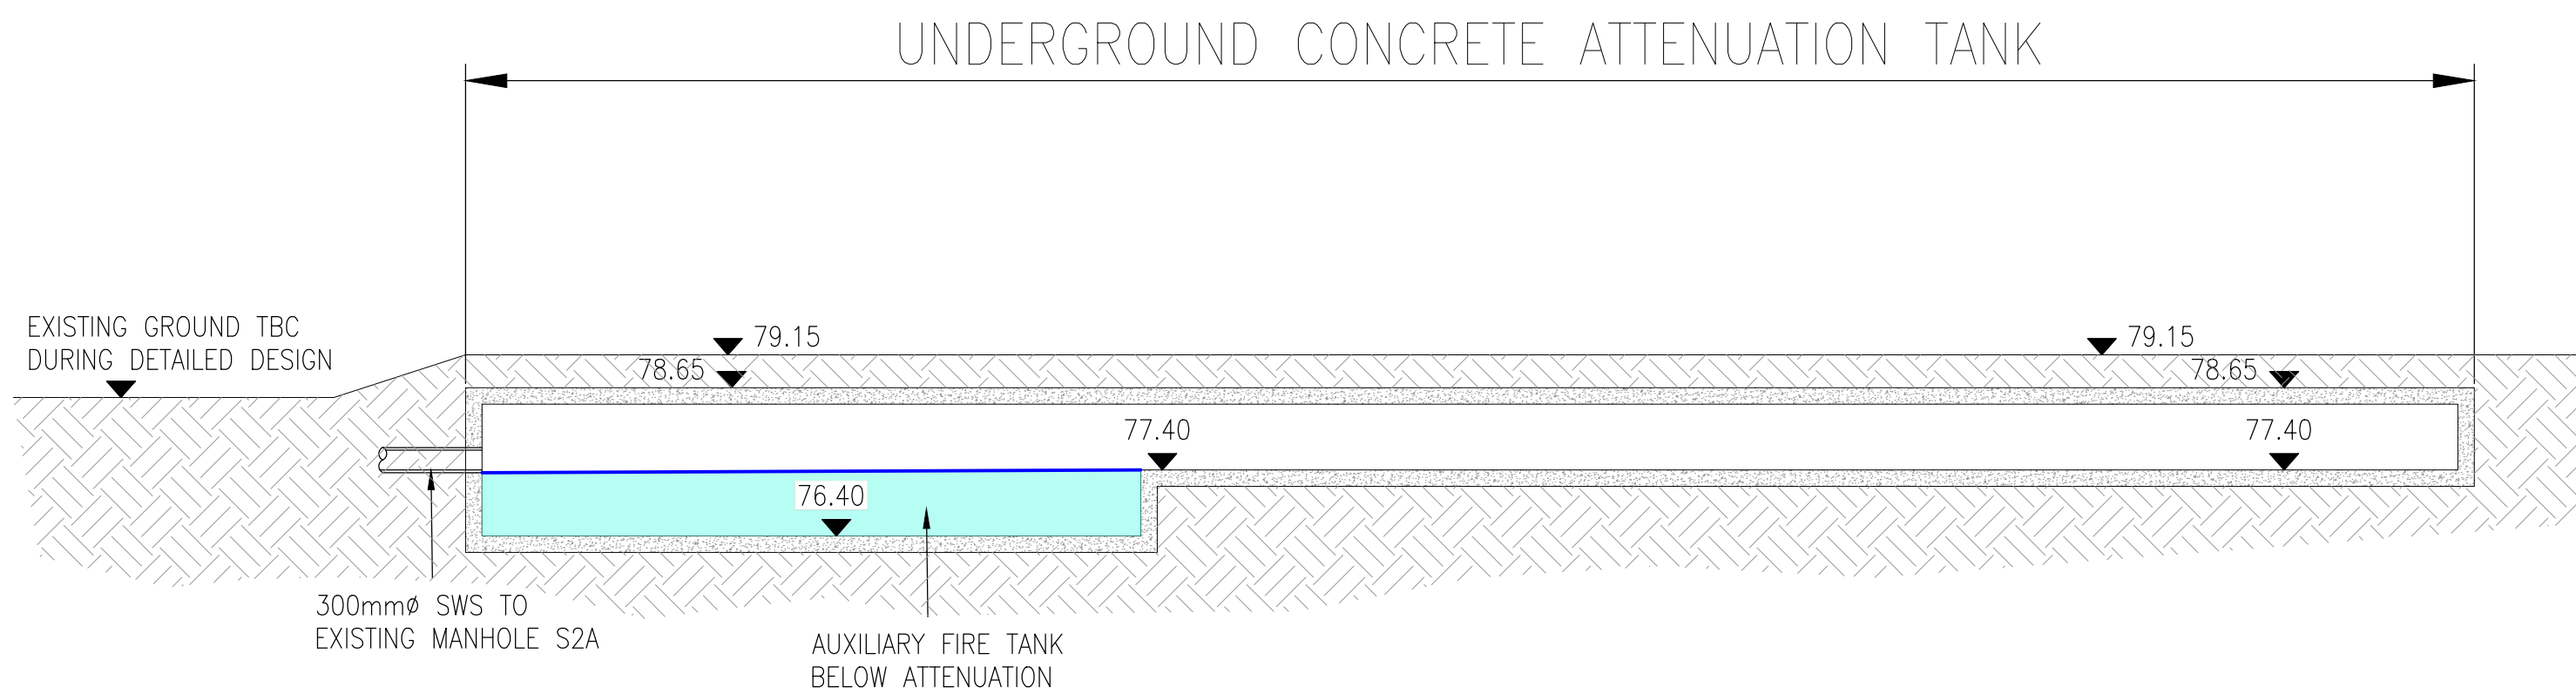


SECTION B-B
SCALE 1:100 @A1

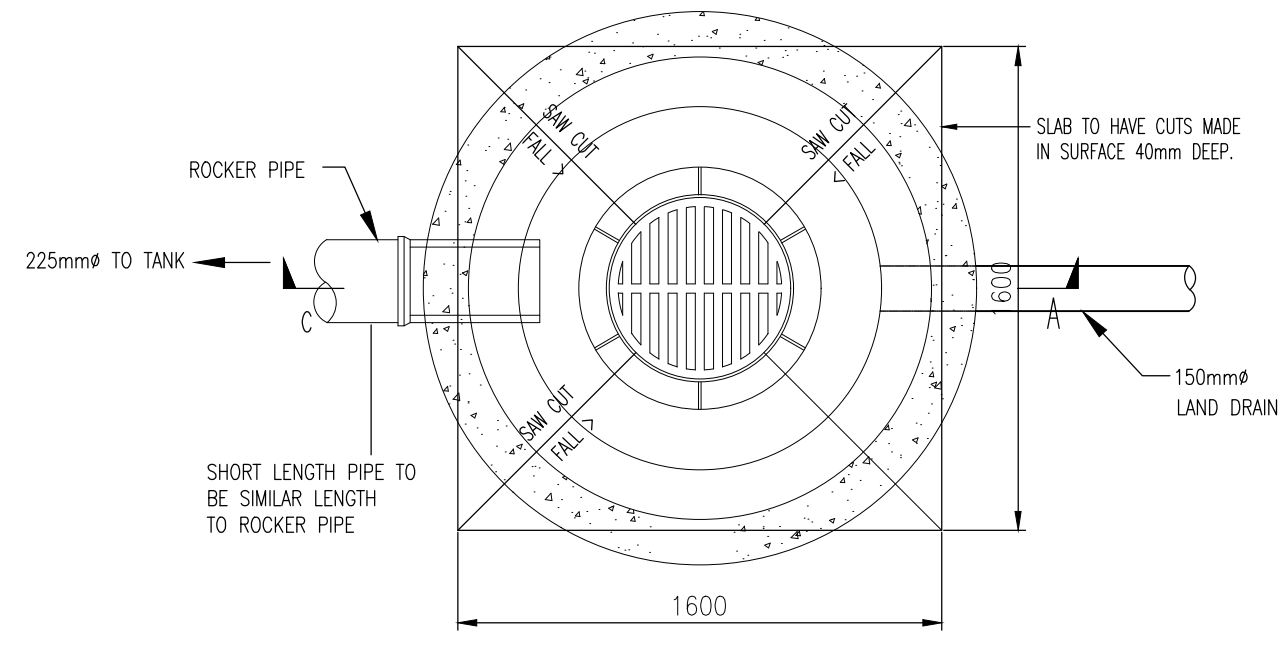

PLAN OF ATTENUATION AREA
SURCHARGE MANHOLE
DETAIL A
SCALE 1:25 @A1

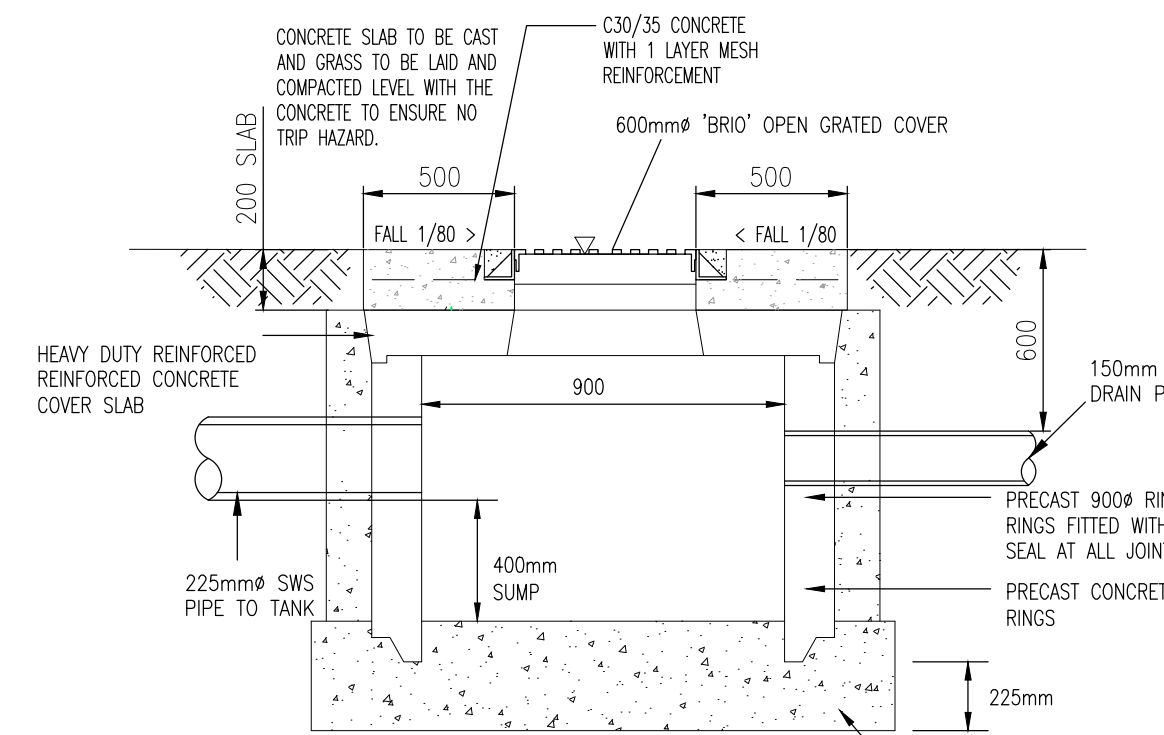

SECTION C-C
ATTENUATION AREA SURCHARGE MANHOLE
SCALE 1:25 @A1

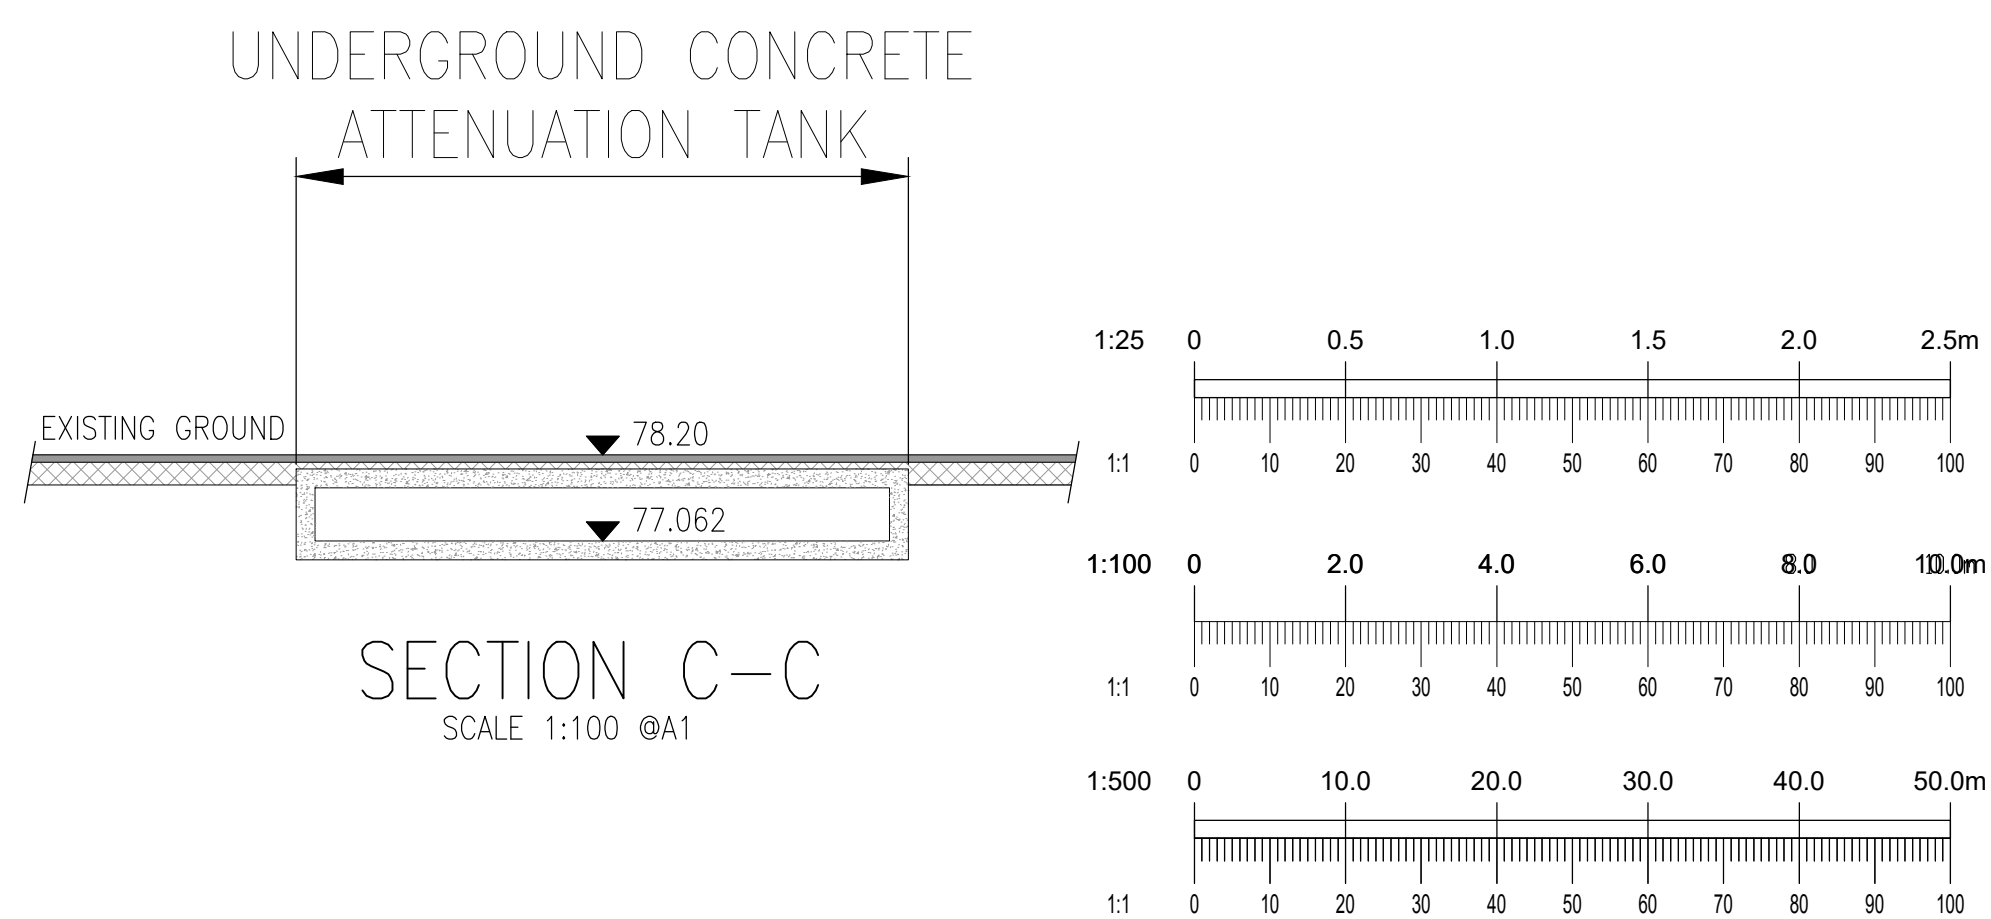

SECTION C-C
SCALE 1:100 @A1

This drawing should not be scaled. Dimensions to be verified on site.
Any discrepancies should be referred to the Engineer prior to work being put in hand.
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1-355 1 664 8900.

NOTES:

- DO NOT SCALE. USE FIGURED DIMENSIONS ONLY.
- THIS DRAWING IS TO BE READ IN CONJUNCTION WITH ALL OTHER RELEVANT ARCHITECTURAL AND ENGINEERING DRAWINGS.

Rev	Date	Description	By	Chk
Amendments				

Project	ST. MARGARETS RECYCLING & TRANSFER CENTRE, SANDYHILL, ST. MARGARETS, CO.DUBLIN			
Title	ATTENUATION DETAILS			
Client				



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Status	PLANNING			
Designed By	JB	Approved	IW	Waterman Ref 23-072
Drawn By	G.Byrne	Date	DEC. 2024	Scales @ A1 AS SHOWN
Project	Originator	Volume	Level	Type
MAR - WMC - ZZ -GF-DR- C - P025				